LINDBROOK DR 60.00' 55.00' 57.50' 57.50' 57.50' 57.50' 57.50' 57.50' 57.50' 57.50' 57.50' 57.50' 57.50' 57.50' 57.50' 57.50' 57.50' SUBJECT PROPERTY

NEW 2 STORY O/ BASEMENT S.F.D. for Mr. & Mrs. KHAIAT, LOS ANGELES, CA





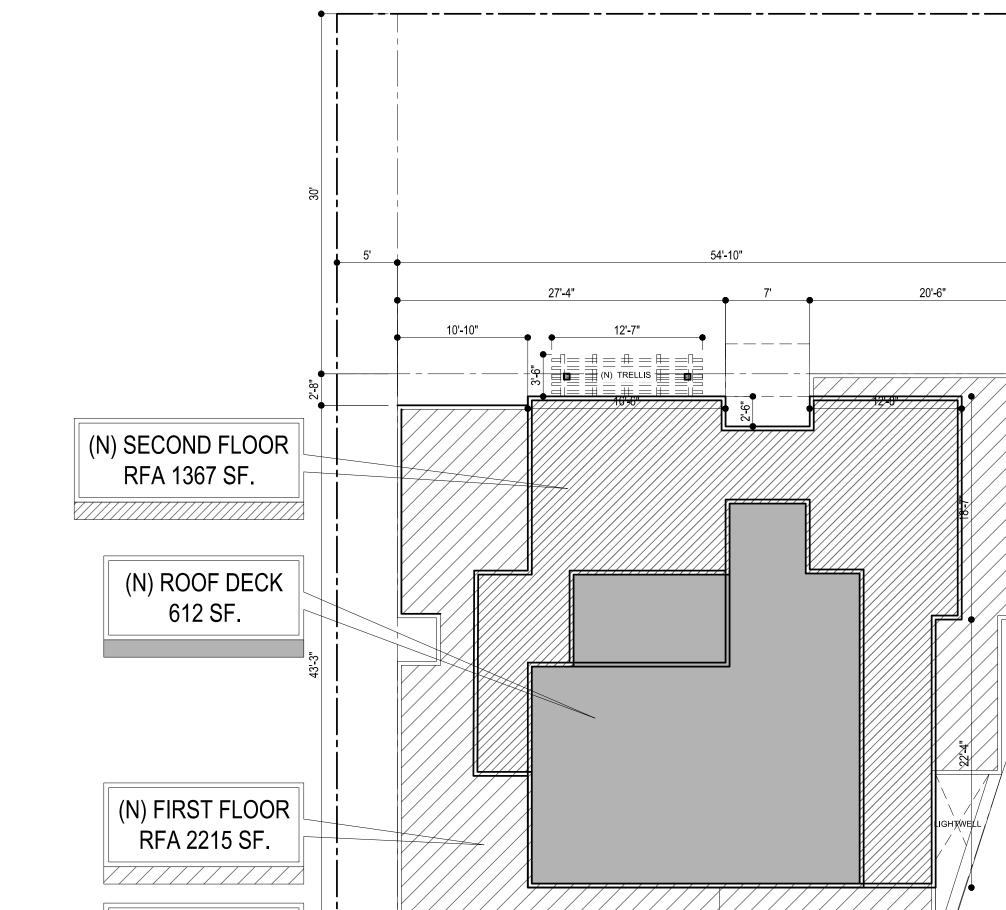
21243 Ventura Blvd. # 115 Woodland Hills, CA 91364

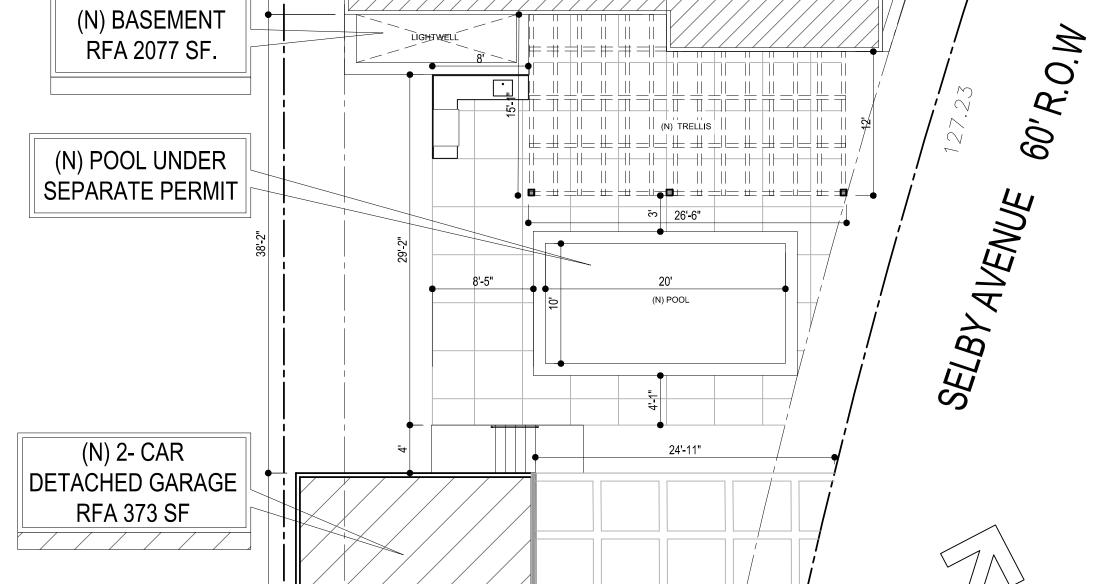
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www.dizittiarchitects.com

LINDBROOK DRIVE 60' R.O.W





41.07

(N) DRIVEWAY W/ PAVERS

20'-4"

SITE PLAN

PRELIMINARY SHEET TITLE:

SCALE:

DRAWN BY:

REVISIONS

CAD FILE: 2108-KHAIAT-MSTR1

DATE: APRIL 16, 2021

AS NOTED

SITE PLAN & **GENERAL NOTES** DRAWING NUMBER

JOB #: 2108-KHAIAT

PREVAILING SETBACK MAP

DRAFTING CONVENTION NOTES LARGE SCALE DRAWINGS TAKE PRECEDENCE OVER SMALL SCALE DRAWINGS. DETAILS TAKE PRECEDENCE OVER ALL. NOTIFY ARCHITECT OF CONFLICTS OR DISCREPANCIES IN WRITING.

a) HORIZONTAL DIMENSIONS ARE SHOWN FROM FACE OF FINISH, UNLESS OTHERWISE NOTED

1" = 50' - 0"

I DO NOT SCALE DRAWINGS. IF ANY ITEM OF WORK CANNOT BE LOCATED. DO NOT PROCEED WITH THE WORK BEFORE CLARIFYING WITH ARCHITECT. h) VERIFY DIMENSIONS MARKED "V.I.F." PRIOR TO START OF CONSTRUCTION. REPOR

DEFINITION OF TERMINOLOGY:

INCONSISTENCIES TO ARCHITECT

"TYPICAL" MEANS IDENTICAL FOR ALL CONDITIONS, UNLESS OTHERWISE NOTED. "SIMILAR" MEANS COMPARABLE CHARACTERISTICS FOR THE CONDITIONS NOTED. VERIFY DIMENSIONS AND ORIENTATION ON PLANS AND ELEVATIONS.

"PROVIDE" MEANS FURNISH AND INSTALL, COMPLETE AND IN PLACE. i) "furnish" means furnish only, installation by general contractor unless otherwise

e) "INSTALL" MEANS PUT INTO PLACE, SUPPLIED BY GENERAL CONTRACTOR UNLESS OTHERWISE

SITE SPECIFIC NOTES

f) "ALIGN" MEANS ACCURATELY LOCATE FINISH FACES IN THE SAME PLANE.

Deed Ref No. (City Clerk) 735847,7-820,56526,618992,2546815,2319609,2005920-1 1827676,1565128,1533324,133508-09,1074127,1032521 1019551,1002389 Building 1

1939 D95C **Building Class** Number of Units Number of Bedrooms Number of Bathrooms Building Square Footage 2,495.0 (sq ft) Additional Information

Airport Hazard None Coastal Zone Area Not Mapped Farmland Area Urban Agriculture Incentive Zone Very High Fire Hazard Severity Zone No Fire District No. 1 Flood Zone Outside Flood Zone Watercourse Hazardous Waste / Border Zone Prop No

Zoning Information (ZI) ZI-2192 ZI-2452 Methane Hazard Site Methane Buffer Zone High Wind Velocity Areas ZI-2462 Special Grading Area General Plan Land Use Low Residential (BOE Basic Grid Map A-13372) General Plan Note(s) Hillside Area (Zoning Code) No Oil Wells Specific Plan Area: West L.A. Transportation Improvement & Seismic Hazards

PARCEL PROFILE REPORT:

PREV. SETBACK CALCULATIONS

57.50

57.50

57.50

57.50

57.50

57.50

PAGE 632 - GRID B3

4360004001

M B 121-42/46

TR 9070

132B153

2652.00

West Los Angeles

CD 5 - Paul Koretz

West Los Angeles

Clear

Address/Legal Information

Thomas Brothers Grid

Arb (Lot Cut Reference)

Jurisdictional Information Community Plan Area

Neighborhood Council

LADBS District Office

Council District

Census Tract #

Special Notes

Mitigation

Design Review Board

Mills Act Contract

SN: Sign District

Central City Parking

Downtown Parking Building Line

500 Ft School Zone

Assessor Information Assessor Parcel No. (APN)

Assessed Land Val.

Last Sale Amount

Tax Rate Area

APN Area (Co. Public Works)*

Assessed Improvement Val. Last Owner Change

500 Ft Park Zone

Use Code

Adaptive Reuse Incentive Area

Affordable Housing Linkage Fee

Residential Market Area

Non-Residential Market Area Transit Oriented Communities (TOC)

CRA - Community Redevelopment Agency None

4360004001

0100 - Residential -

0.185 (ac)

\$1,634,236 \$456,233

01/11/2011

Streetscape

Area Planning Commission

Planning and Zoning Information

Map Reference

Map Sheet

Block

Assessor Parcel No. (APN)

Lot/Parcel Area (Calculated) 8,140.8 (sq ft)

Number of lots: 9 Prevailing Setback: 30.00 ft

Total no of lots entered: 9

Total frontage entered: 527.96 ft 40% from total frontage entered: 211.18 ft

No of lots used in the calculation: 9

Lot Frontage (ft) Setback (ft)

View Calculation Details

Setback range used: 27.00 ft - 34.00 ft

Total frontage used in the calculation: 527.96 ft

28.00

32.00

30.00

28.00

29.00

Nearest Fault (Distance in km) Special Land Use / Zoning Santa Monica Fault Nearest Fault (Name) Transverse Ranges Historic Preservation Review Los Angeles Basin Historic Preservation Overlay Zone Fault Type Other Historic Designations 1.00000000 Other Historic Survey Information Slip Rate (mm/year) Left Lateral - Revers Slip Geometry Oblique CDO: Community Design Overlay Moderately -CPIO: Community Plan Imp. Overlay **Poorly Constrained** Down Dip Width (km) 13.0000000 CUGU: Clean Up-Green Up Rupture Top 0.0000000 NSO: Neighborhood Stabilization Overlay POD: Pedestrian Oriented Districts 13.0000000 Rupture Bottom Dip Angle (degrees) -75.000000

Active Fault Near-Source Zone

Maximum Magnitude 6.60000000 Alquist-Priolo Fault Zone Liquefaction Preliminary Fault Rupture Study Area Tsunami Inundation Zone Economic Development Areas Promise Zone Renewal Community Revitalization Zone None State Enterprise Zone Targeted Neighborhood Initiative Public Safety

Police Information Single Family Residence West Los Angeles

District / Fire Station 37

Red Flag Restricted Parking

| LOT AREA: 14,941 SF x 40% + 1,500= 7,476.4 SF MAX R.F.A. > 3,058 SF addition is O.K.

AREAS ARE CALCULATED FOR CODE PURPOSES ONLY. SHOULD BE RECALCULATED FOR ANY OTHER PURPOSES

ELECTRICAL, PLUMBING, GREEN AND ENERGY CODES" "THE PROJECT CONTRACTOR SHALL PROVIDE ALL MEASURES NECESSARY TO PROTECT ADJACENT PROPERTIES, WORKERS, AND OTHER PERSONS DURING EXCAVATION AND SITE PREPARATION _THE BUILDING SHALL BE EQUIPPED WITH AN AUTOMATIC RESIDENTIAL FIRE SPRINKLER SYSTEM IN

"PROJECT SHALL COMPLY WITH THE 2019 CALIFORNIA BUILDING, RESIDENTIAL, MECHANICAL

ACCORDANCE WITH SECTION R313.3 or NFPA13D. (R313, 12.21A17(d)) THE SPRINKLER SYSTEM SHALL BE APPROVED BY PLUMBING DIVISION PRIOR TO INSTALLATION.

LEGAL DESCRIPTION

PROJECT ADDRESS: 10750 LINDBROOK DR., LOS ANGELES, CA 90024 BUILDING DEPARTMENT: CITY OF WEST LOS ANGLES

4360-004-001 TYPE OF CONSTRUCTION: V-B TR 9070 LOT: 1 BLOCK: 9 TRACT: MAP REF.: M B 121-42/46 MAP SHEET: 132B153 R1-1-0 LOT SIZE: 8,140.8 (sq ft)

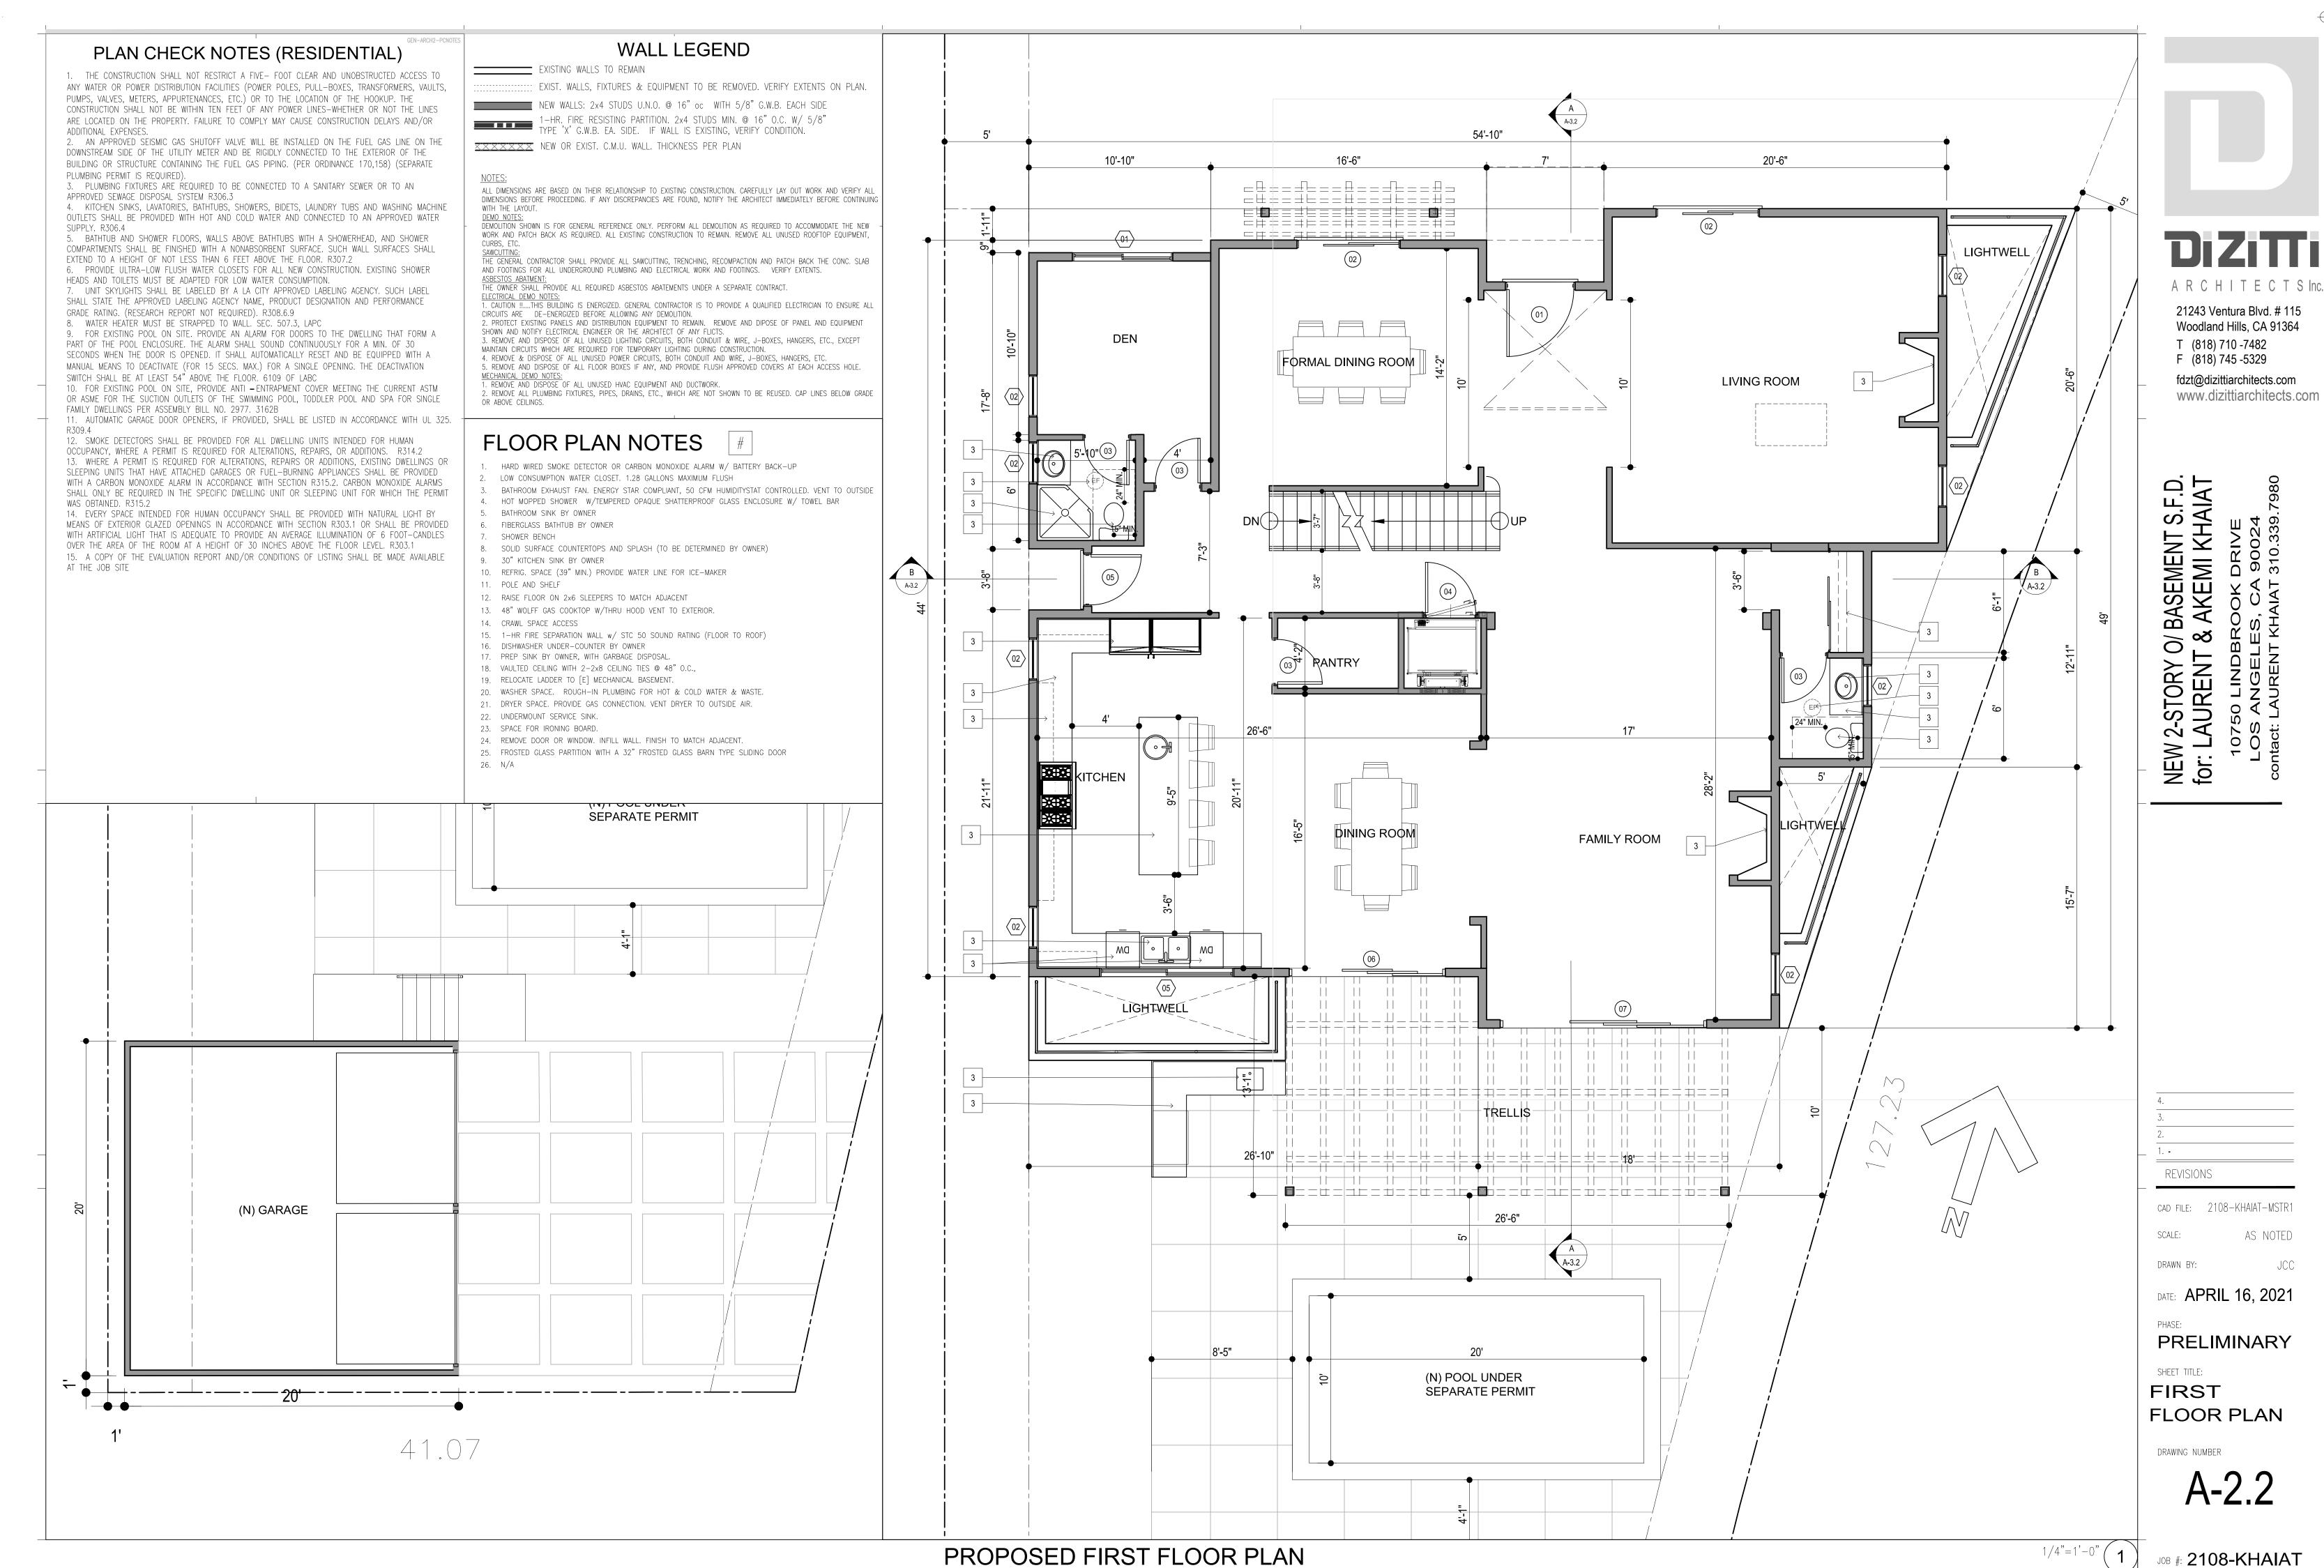
SCOPE OF WORK

FLOOR AREA ANALYSIS

NEW 1,199 SF THREE-STORY ACCESSORY DWELLING UNIT PER G TYPE V-B ON SLAB FOUNDATION

| e - | | SCHOOL FEES | | | | | |
|----------------|--|-------------|------|--------|--|--|--|
| | DESCRIPTION | ZON'G. CODE | AREA | R.F.A. | | | |
| 00 | [E] S.F.D. | _ | _ | | | | |
| | ENTRY PORCH | _ | _ | | | | |
| SAS | STORAGE | _ | _ | _ | | | |
| AREAS | GARAGE | _ | _ | _ | | | |
| 9 | PATIO COVERS | _ | _ | _ | | | |
| EXISTING | OTHER AREAS | _ | _ | _ | | | |
| | TOTAL EXISTING | _ | _ | _ | | | |
| | FIRST FLOOR | _ | _ | _ | | | |
| | SECOND FLOOR | _ | _ | _ | | | |
| | BASEMENT | _ | _ | _ | | | |
| PROPOSED AREAS | GARAGE | _ | _ | _ | | | |
| D A F | - | _ | _ | _ | | | |
| SE | - | _ | _ | _ | | | |
| SOPC | - | _ | _ | _ | | | |
| H | TOTAL PROPOSED | | | _ | | | |
| | TOTAL | | | _ | | | |
| 10 | AREA: 14 941 SE x 40% + 1 500= 7 476 4 SE MAX R F A > 3 058 SE addition is O K | | | | | | |

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| L | | | | | 1 | | | | | | |
|-----------------|---------------|------|--------------------------------|-----|-------|---------------|----------|--|--|--|--|
| DOOR SCHEDULE | | | | | | | | | | | |
| SYM. | SIZE | TYPE | DESCRIPTION | QTY | FRAME | NOTATION | | | | | |
| 1 | 2'-8"x 6'-8" | 1 | EXT. SINGLE HINGED SIDE ENTRY | 3 | WOOD | 1, 3, 4, 5 | 1 | | | | |
| 2 | 2'-8"x 6'-8" | 2 | INT. SINGLE HINGED DOOR | 11 | WOOD | 1, 2 | | | | | |
| 3 | 2'-8"x 6'-8" | 3 | INT. SINGLE POCKET DOOR | 2 | WOOD | 1, 2 | 7 | | | | |
| 4 | 6'-0"x 6'-8" | 4 | INT. DOUBLE SLDG. CLOSET DOOR | 6 | WOOD | 1, 2 | | | | | |
| 5 | 5'-0"x 6'-8" | 4 | INT. DOUBLE SLDG. CLOSET DOOR | 1 | WOOD | 1, 2 | 3 | | | | |
| 6 | 5'-0"x 6'-8" | 7 | EXT. DOUBLE HINGED FRENCH DOOR | 3 | WOOD | 1, 3, 4, 5 | | | | | |
| 7 | 2'-8"x 6'-8" | 6 | EXT. SINGLE HINGED FRENCH DOOR | 3 | WOOD | 1, 3, 4, 5 | 4 | | | | |
| 8 | 2'-6"x 6'-8" | 2 | INT. SINGLE HINGED DOOR | 1 | WOOD | 1, 2 | <u> </u> | | | | |
| 9 | 5'-0"x 6'-8" | 7 | EXT. DBL HINGED SIDE ENTRY | 1 | WOOD | 1, 3, | | | | | |
| WINDOW SCHEDULE | | | | | | | | | | | |
| SYM. | SIZE | TYPE | DESCRIPTION | QTY | FRAME | NOTATION | 6 | | | | |
| 1 | 3-0" x 4'-6" | 1 | DOUBLE CASEMENT | 3 | VINYL | 1,2,4,5,7,8,9 | | | | | |
| (2) | 2'-0" x 3'-6" | 2 | SGL. CASEMENT WINDOW | 3 | VINYL | 1,2,4,5,7,8,9 | 8 | | | | |

OPENABLE SIDELIGHT

DOUBLE CASEMENT

 $4 - 0 \times 4 - 0$

1. VERIFY ALL ROUGH OPENINGS AND DIMENSIONS PRIOR TO INSTALLATION.

NOTES

1,3,4,5,7

1,2,4,5,7,8,9

2 | WOOD

4 VINYL

2. ALL NEW VINYL WINDOWS, AND SLIDING DOORS SHALL BE 'MILGARD' WITH DUAL PANE GLAZING. [VERIFY BRAND W/ OWNER]. WITH A U FACTOR < 0.32 AND SHGC < 0.25. FOLLOW MNFCTR'S INSTRUCTIONS FOR PROPER HANDLING INSTALLATION & MAINTENANCE. 3. WOOD EXTERIOR FRENCH AND INTERIOR DOORS TO BE T.M.COBB OR EQUAL. FOLLOW MANUFACTURER'S INSTRUCTIONS FOR PROPER HANDLING, INSTALLATION AND MAINTENANCE.

4. ALL NEW EXTERIOR DOORS SHALL HAVE RESILIENT STOPS, AND SHALL BE FULLY GASKETED TO LIMIT AIR INFILTRATION. 5. PROVIDE TEMPERED GLASS AT ALL GLASS DOORS (DOORS W/ GLASS IN THEM), ADJACENT PANELS, AND ALL GLAZED OPENINGS WITHIN 18" OF AN ADJACENT FLOOR, APPROVED FOR IMPACT HAZARD, AND SHALL HAVE THE MANUFACTURER'S NAME PERMANENTLY SHOWN ON THE GLASS.

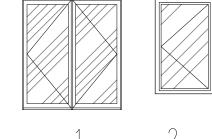
6. DOOR & FRAME BETWEEN GARAGE AND HOUSE TO BE 3/4 HR. RATED. PROVIDE U.L. LABEL & SELF CLOSING HARDWARE. 7. PROVIDE SCREEN AT ALL OPERABLE WINDOWS 8. WHEN REQUESTED BY OWNER, PROVIDE OBSCURE OR PRIVACY GLASS AT BATHROOM WINDOWS. IN EACH BEDROOM, AT LEAST ONE WINDOW SHALL BE PROVIDED AS A MEAN OF ESCAPE OR RESCUE. IT SHALL HAVE A FINISHED SILL

AUTOMATIC GARAGE DOOR OPENERS SHALL BE LISTED IN

ACCORDANCE WITH UL 325. (R309.4)

HEIGHT OF NOT MORE THAN 44" ABOVE THE FINISHED FLOOR. WHEN OPENED, SHOULD PROVIDE A MIN OPENABLE AREA OF 5.7 SQ FT. WITH A MIN WIDTH OF 20" CLEAR AND A MIN HEIGHT OF 24"

DOORS



_____ EXISTING WALLS TO REMAIN

EXIST. WALLS, FIXTURES & EQUIPMENT TO BE REMOVED. VERIFY EXTENTS ON PLAN. NEW WALLS: 2x4 STUDS U.N.O. @ 16" oc WITH 5/8" G.W.B. EACH SIDE

WALL LEGEND

1-HR. FIRE RESISTING PARTITION. 2x4 STUDS MIN. @ 16" O.C. W/ 5/8" TYPE 'X' G.W.B. EA. SIDE. IF WALL IS EXISTING, VERIFY CONDITION. XXXXXXX NEW OR EXIST. C.M.U. WALL. THICKNESS PER PLAN

ALL DIMENSIONS ARE BASED ON THEIR RELATIONSHIP TO EXISTING CONSTRUCTION. CAREFULLY LAY OUT WORK AND VERIFY ALL DIMENSIONS BEFORE PROCEEDING. IF ANY DISCREPANCIES ARE FOUND, NOTIFY THE ARCHITECT IMMEDIATELY BEFORE CONTINUING

DEMOLITION SHOWN IS FOR GENERAL REFERENCE ONLY. PERFORM ALL DEMOLITION AS REQUIRED TO ACCOMMODATE THE NEW WORK AND PATCH BACK AS REQUIRED. ALL EXISTING CONSTRUCTION TO REMAIN. REMOVE ALL UNUSED ROOFTOP EQUIPMENT,

SAWCUTTING:
THE GENERAL CONTRACTOR SHALL PROVIDE ALL SAWCUTTING, TRENCHING, RECOMPACTION AND PATCH BACK THE CONC. SLAB
AND FOOTINGS FOR ALL UNDERGROUND PLUMBING AND ELECTRICAL WORK AND FOOTINGS. VERIFY EXTENTS. ASBESTOS ABATMENT:
THE OWNER SHALL PROVIDE ALL REQUIRED ASBESTOS ABATEMENTS UNDER A SEPARATE CONTRACT.

ELECTRICAL DEMO NOTES:

1. CAUTION !!....THIS BUILDING IS ENERGIZED. GENERAL CONTRACTOR IS TO PROVIDE A QUALIFIED ELECTRICIAN TO ENSURE ALL CIRCUITS ARE DE—ENERGIZED BEFORE ALLOWING ANY DEMOLITION.

CIRCUITS ARE DE—ENERGIZED BEFORE ALLOWING ANY DEMOLITION. 2. PROTECT EXISTING PANELS AND DISTRIBUTION EQUIPMENT TO REMAIN. REMOVE AND DIPOSE OF PANEL AND EQUIPMENT

SHOWN AND NOTIFY ELECTRICAL ENGINEER OR THE ARCHITECT OF ANY FLICTS. 3. REMOVE AND DISPOSE OF ALL UNUSED LIGHTING CIRCUITS, BOTH CONDUIT & WIRE, J-BOXES, HANGERS, ETC., EXCEPT MAINTAIN CIRCUITS WHICH ARE REQUIRED FOR TEMPORARY LIGHTING DURING CONSTRUCTION. 4. REMOVE & DISPOSE OF ALL UNUSED POWER CIRCUITS, BOTH CONDUIT AND WIRE, J-BOXES, HANGERS, ETC.

5. REMOVE AND DISPOSE OF ALL FLOOR BOXES IF ANY, AND PROVIDE FLUSH APPROVED COVERS AT EACH ACCESS HOLE.

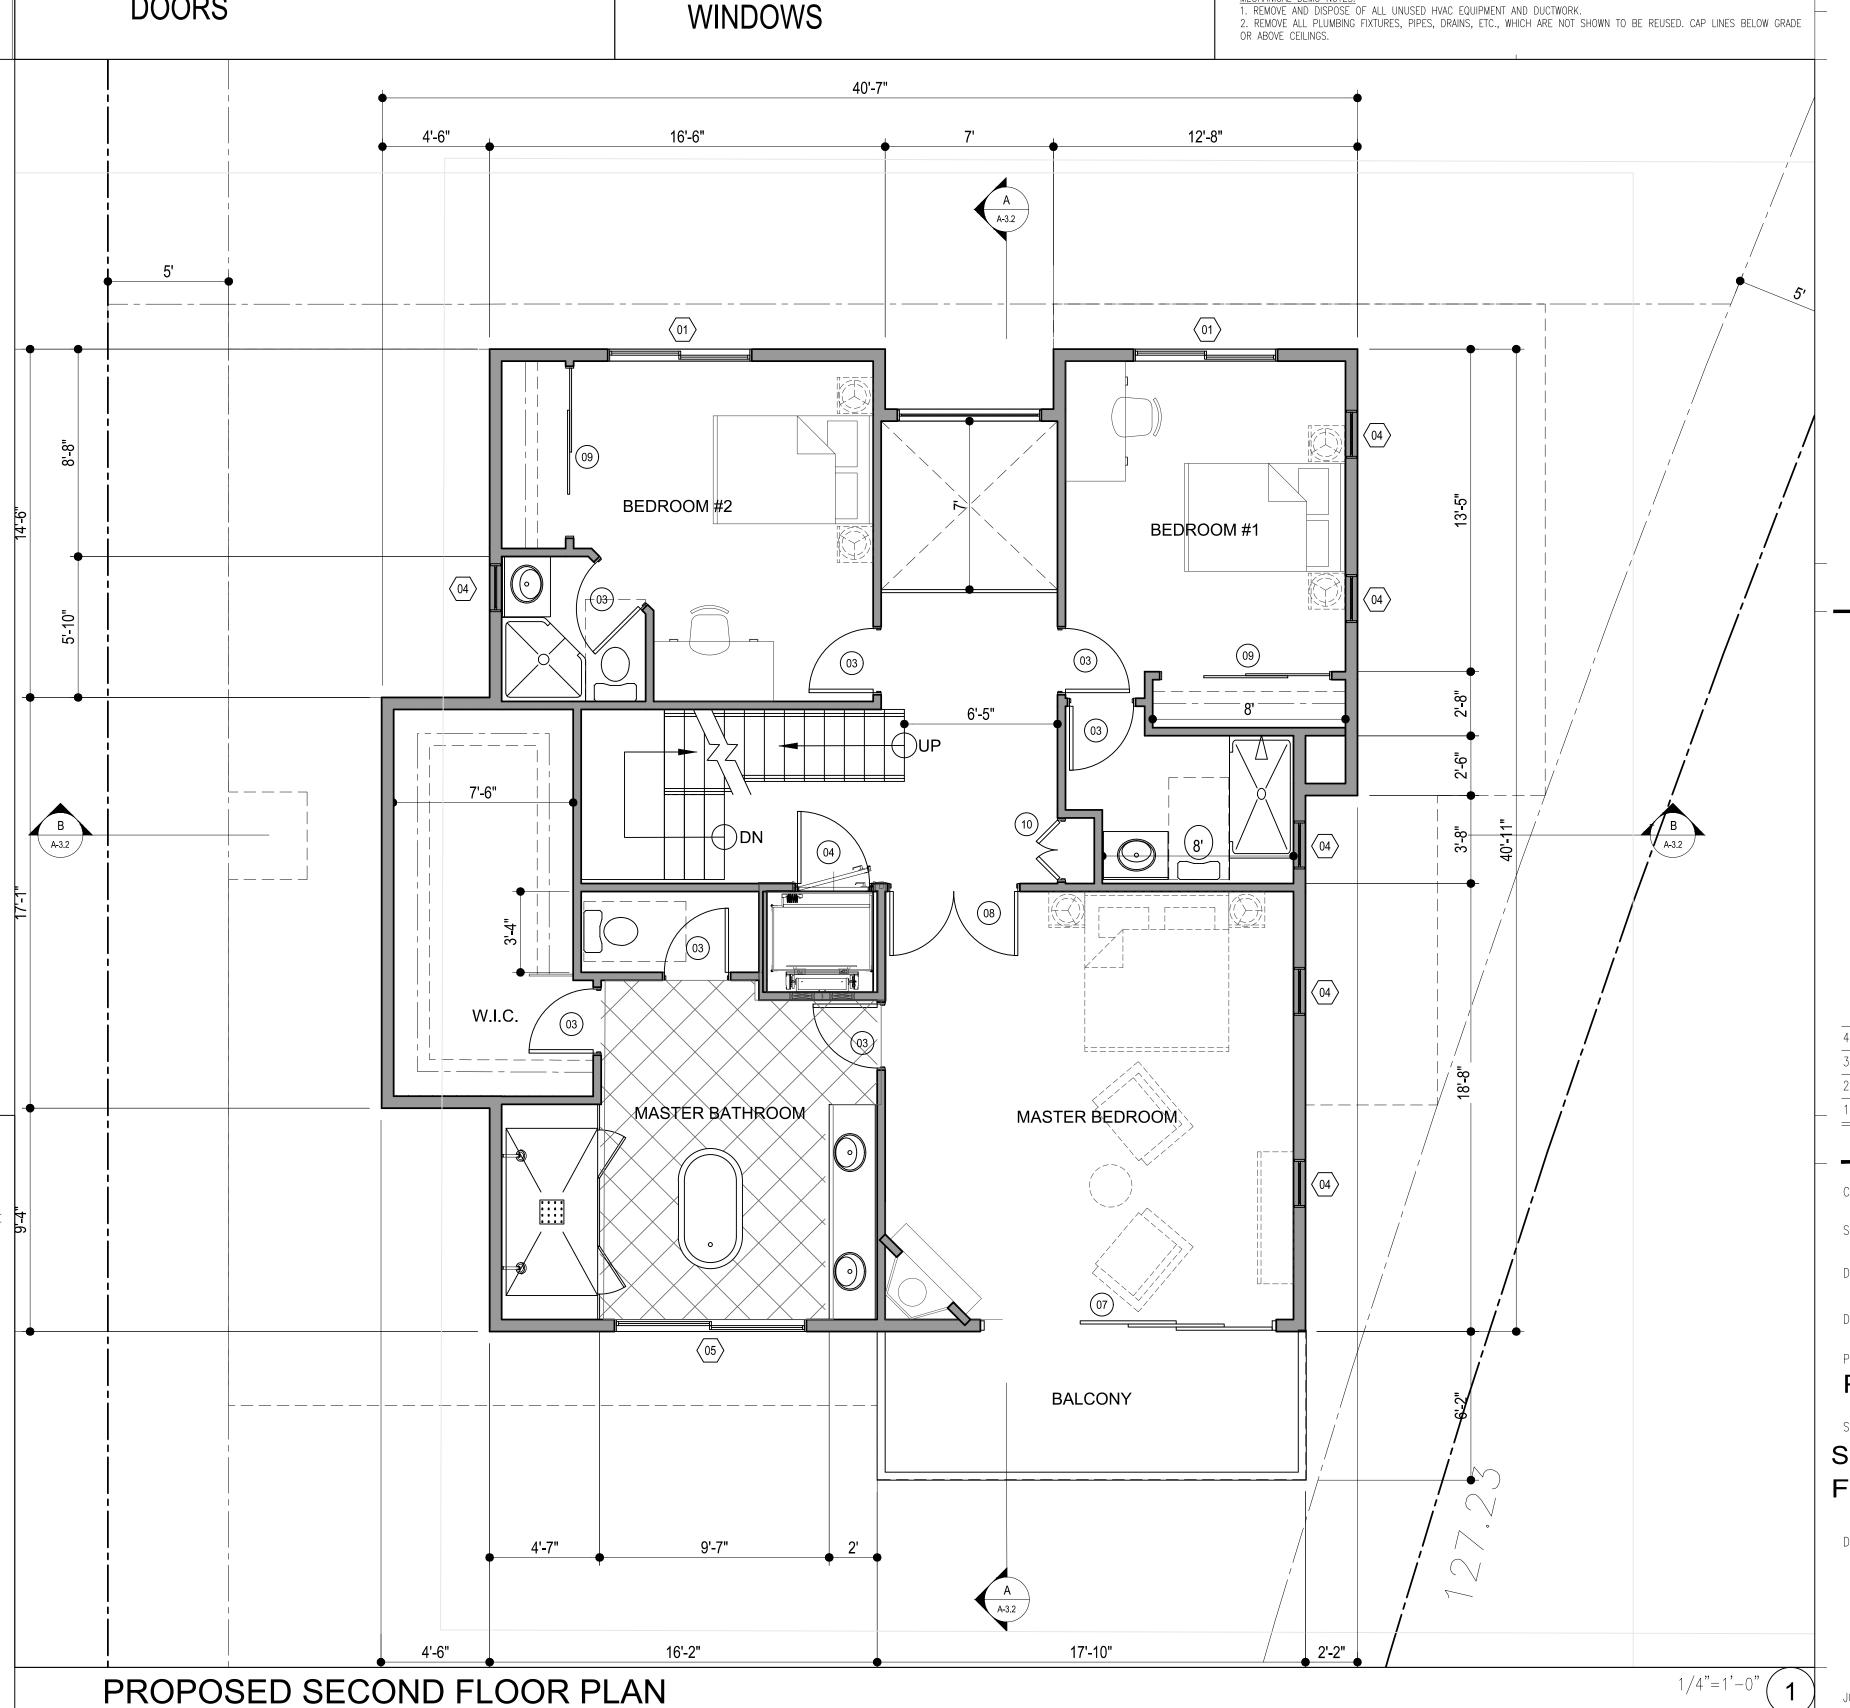
MECHANICAL DEMO NOTES:

1. REMOVE AND DISPOSE OF ALL UNUSED HVAC EQUIPMENT AND DUCTWORK. 2. REMOVE ALL PLUMBING FIXTURES, PIPES, DRAINS, ETC., WHICH ARE NOT SHOWN TO BE REUSED. CAP LINES BELOW GRADE

21243 Ventura Blvd. # 115 Woodland Hills, CA 91364

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REVISIONS

CAD FILE: 2108-KHAIAT-MSTR1

SCALE: AS NOTED DRAWN BY:

DATE: APRIL 16, 2021

PRELIMINARY

SHEET TITLE:

SECOND **FLOOR PLAN**

DRAWING NUMBER

JOB #: 2108-KHAIAT

FLOOR PLAN NOTES #

1. HARD WIRED SMOKE DETECTOR OR CARBON MONOXIDE ALARM W/ BATTERY BACK-UP 2. LOW CONSUMPTION WATER CLOSET. 1.28 GALLONS MAXIMUM FLUSH

3. BATHROOM EXHAUST FAN. ENERGY STAR COMPLIANT, 50 CFM HUMIDITYSTAT CONTROLLED. VENT TO OUTSIDE

4. HOT MOPPED SHOWER W/TEMPERED OPAQUE SHATTERPROOF GLASS ENCLOSURE W/ TOWEL BAR

5. BATHROOM SINK BY OWNER 6. FIBERGLASS BATHTUB BY OWNER

SHOWER BENCH

8. SOLID SURFACE COUNTERTOPS AND SPLASH (TO BE DETERMINED BY OWNER)

9. 30" KITCHEN SINK BY OWNER 10. REFRIG. SPACE (39" MIN.) PROVIDE WATER LINE FOR ICE-MAKER

11. POLE AND SHELF 12. RAISE FLOOR ON 2x6 SLEEPERS TO MATCH ADJACENT

13. 48" WOLFF GAS COOKTOP W/THRU HOOD VENT TO EXTERIOR.

14. CRAWL SPACE ACCESS

15. 1-HR FIRE SEPARATION WALL w/ STC 50 SOUND RATING (FLOOR TO ROOF) 16. DISHWASHER UNDER-COUNTER BY OWNER

17. PREP SINK BY OWNER, WITH GARBAGE DISPOSAL.

18. VAULTED CEILING WITH 2-2x8 CEILING TIES @ 48" O.C.,

19. RELOCATE LADDER TO [E] MECHANICAL BASEMENT. 20. WASHER SPACE. ROUGH-IN PLUMBING FOR HOT & COLD WATER & WASTE. 21. DRYER SPACE. PROVIDE GAS CONNECTION. VENT DRYER TO OUTSIDE AIR.

22. UNDERMOUNT SERVICE SINK.

23. SPACE FOR IRONING BOARD.

24. REMOVE DOOR OR WINDOW. INFILL WALL. FINISH TO MATCH ADJACENT.

25. FROSTED GLASS PARTITION WITH A 32" FROSTED GLASS BARN TYPE SLIDING DOOR

26. N/A

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WALL LEGEND

_____ EXISTING WALLS TO REMAIN

EXIST. WALLS, FIXTURES & EQUIPMENT TO BE REMOVED. VERIFY EXTENTS ON PLAN.

NEW WALLS: 2x4 STUDS U.N.O. @ 16" oc WITH 5/8" G.W.B. EACH SIDE 1-HR. FIRE RESISTING PARTITION. 2x4 STUDS MIN. @ 16" O.C. W/ 5/8" TYPE 'X' G.W.B. EA. SIDE. IF WALL IS EXISTING, VERIFY CONDITION. XXXXXXX NEW OR EXIST. C.M.U. WALL. THICKNESS PER PLAN

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1. CAUTION !!....THIS BUILDING IS ENERGIZED. GENERAL CONTRACTOR IS TO PROVIDE A QUALIFIED ELECTRICIAN TO ENSURE ALL CIRCUITS ARE DE-ENERGIZED BEFORE ALLOWING ANY DEMOLITION.

2. PROTECT EXISTING PANELS AND DISTRIBUTION EQUIPMENT TO REMAIN. REMOVE AND DIPOSE OF PANEL AND EQUIPMENT SHOWN AND NOTIFY ELECTRICAL ENGINEER OR THE ARCHITECT OF ANY FLICTS.

3. REMOVE AND DISPOSE OF ALL UNUSED LIGHTING CIRCUITS, BOTH CONDUIT & WIRE, J-BOXES, HANGERS, ETC., EXCEPT MAINTAIN CIRCUITS WHICH ARE REQUIRED FOR TEMPORARY LIGHTING DURING CONSTRUCTION. 4. REMOVE & DISPOSE OF ALL UNUSED POWER CIRCUITS, BOTH CONDUIT AND WIRE, J-BOXES, HANGERS, ETC.
5. REMOVE AND DISPOSE OF ALL FLOOR BOXES IF ANY, AND PROVIDE FLUSH APPROVED COVERS AT EACH ACCESS HOLE. MECHANICAL DEMO NOTES:

1. REMOVE AND DISPOSE OF ALL UNUSED HVAC EQUIPMENT AND DUCTWORK.

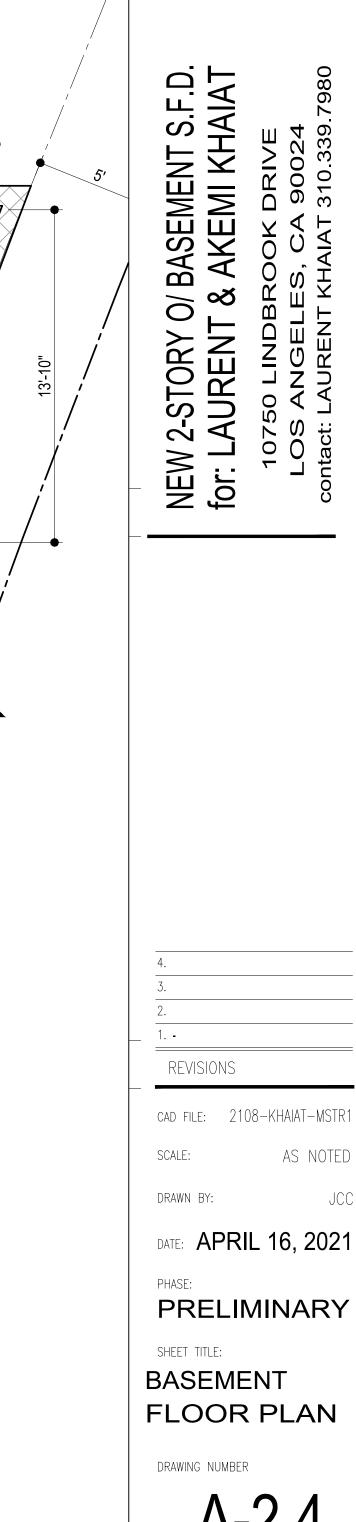
2. REMOVE ALL PLUMBING FIXTURES, PIPES, DRAINS, ETC., WHICH ARE NOT SHOWN TO BE REUSED. CAP LINES BELOW GRADE

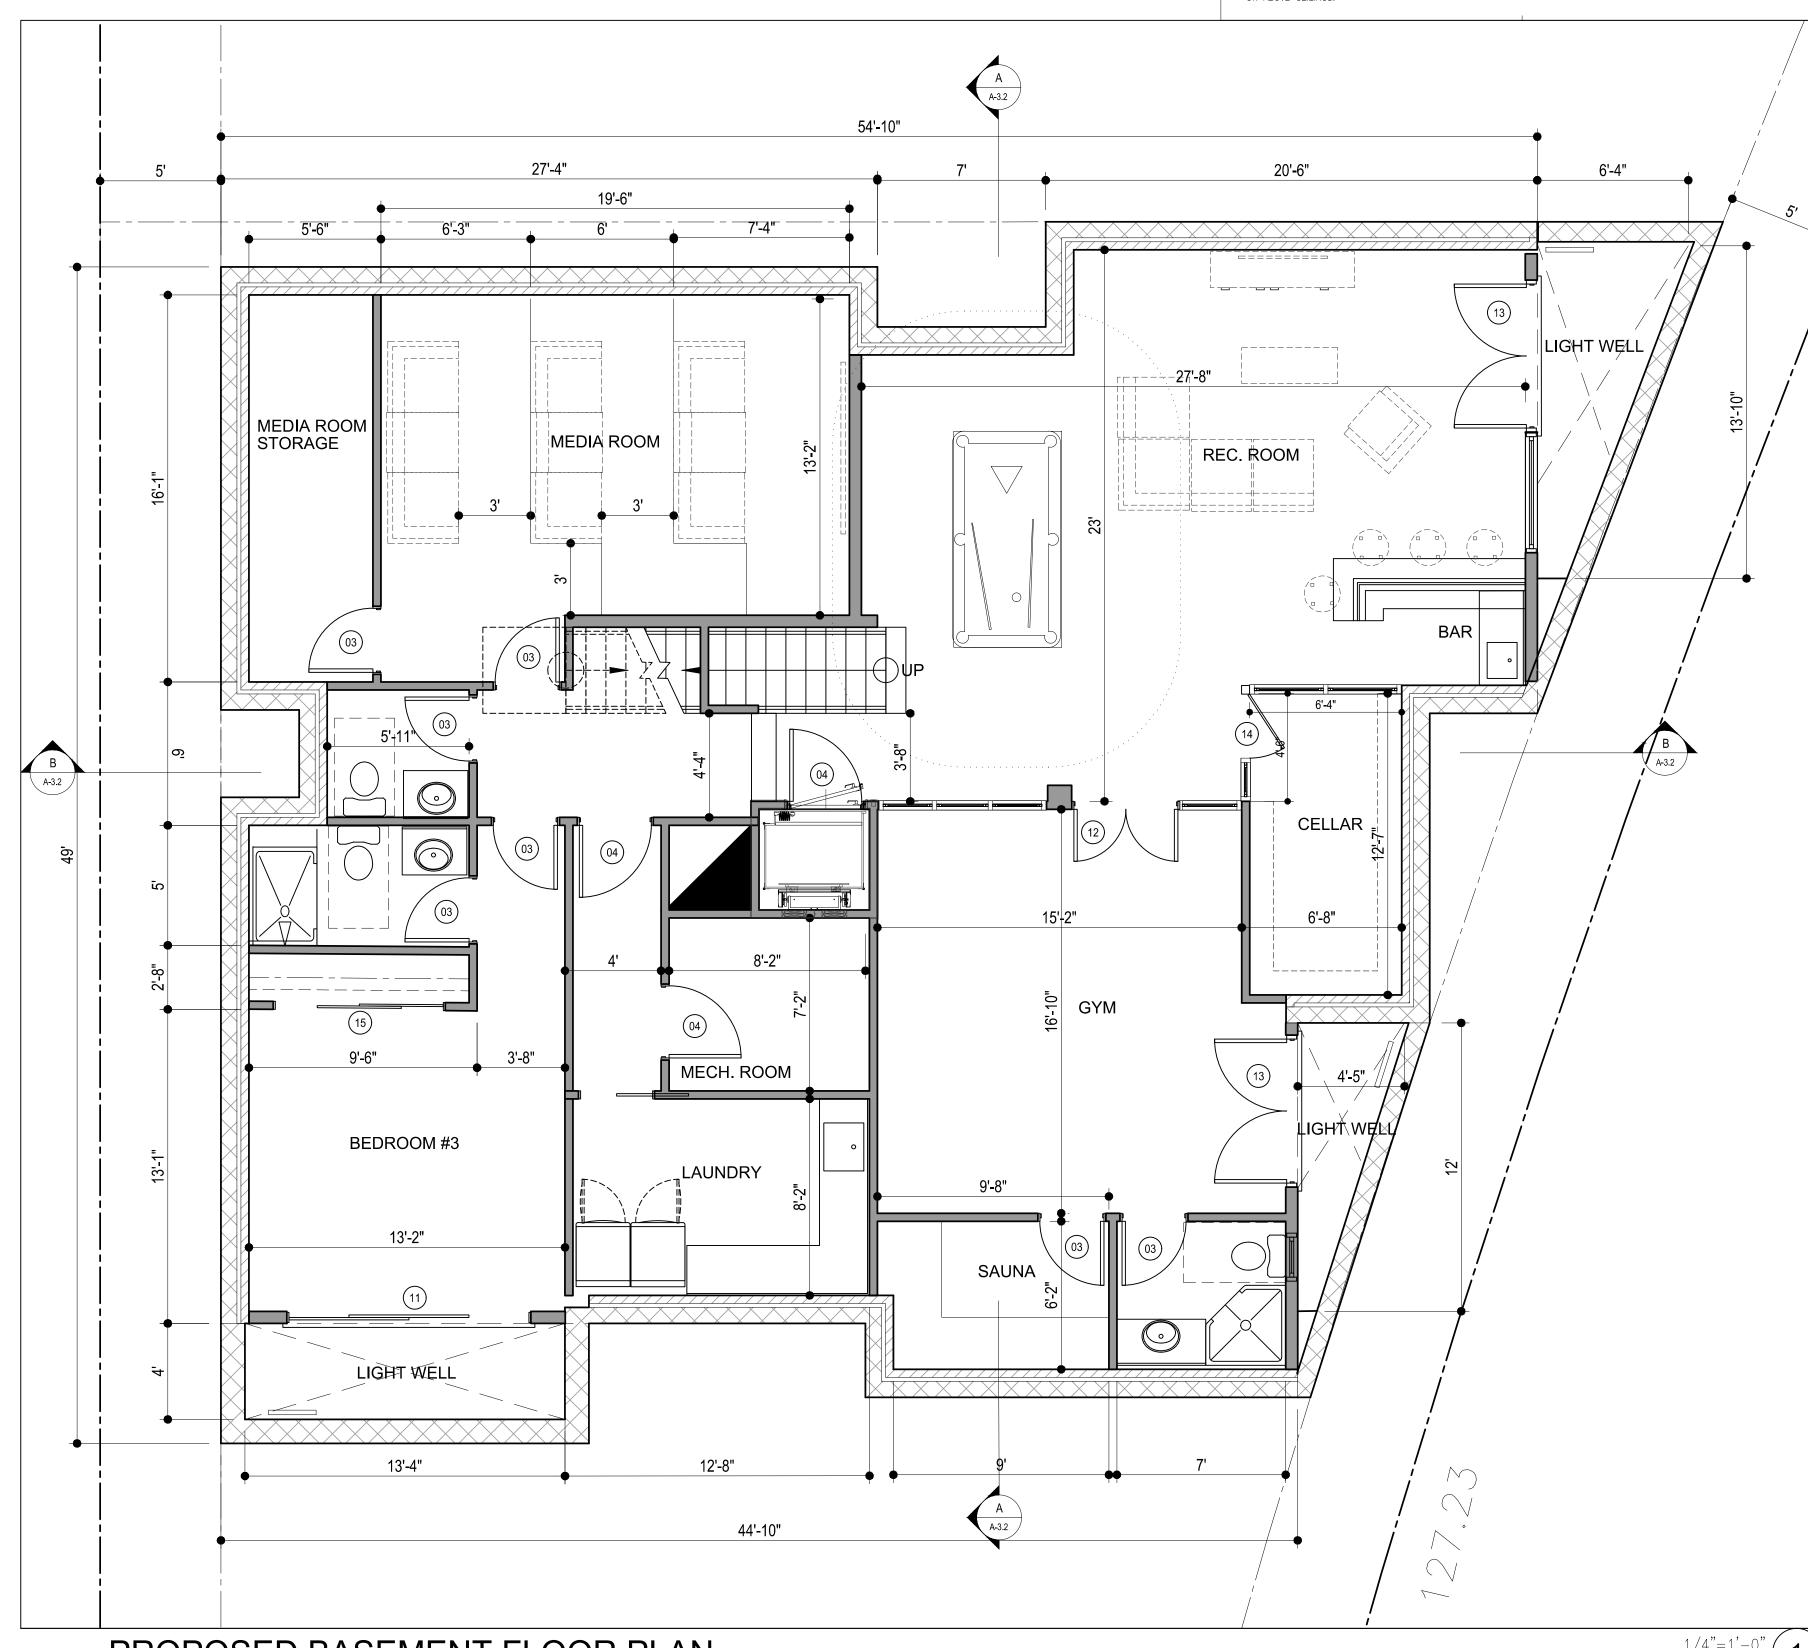
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AS NOTED

ELEVATIONS / SECTIONS NOTES

1. EXTERIOR STUCCO OVER METAL LATH AND 15 LBS. MIN. FELT PAPER COLOR AND TEXTURE TO BE SELECTED BY OWNER.

2. RAIN TANK PER L.I.D.

3. RAIN GUTTER

4. CLASS 'A' FIRE RETARDANT 20 YR. MIN. COMPOSITION SHINGLES. SEE SPECS ON ROOF PLAN.

5. EXTERIOR EXPOSED OPEN HARDWOOD DECKING. MATERIAL APPROVED PER L.A. BLDG. CODE

6. WATER CRICKET

7. EXISTING ROOF LINE TO BE REMOVED

8. R-38 COMPRESSED FIBER MINERAL BATT. INSULATION 9. R-13 FIBER MINERAL BATT. INSULATION AT ALL EXTERIOR WALLS

10. NEW DOORS PER SCHEDULE. [SEE A-2]

11. NEW WINDOWS PER SCHEDULE. [SEE A-2]

12. EXISTING ROOF RAFTER

13. 2x4 DOUBLE PLATE

14. 2x4 P.T. SILL PLATE

15. NEW RIDGE BOARD

16. EXISTING HEADER

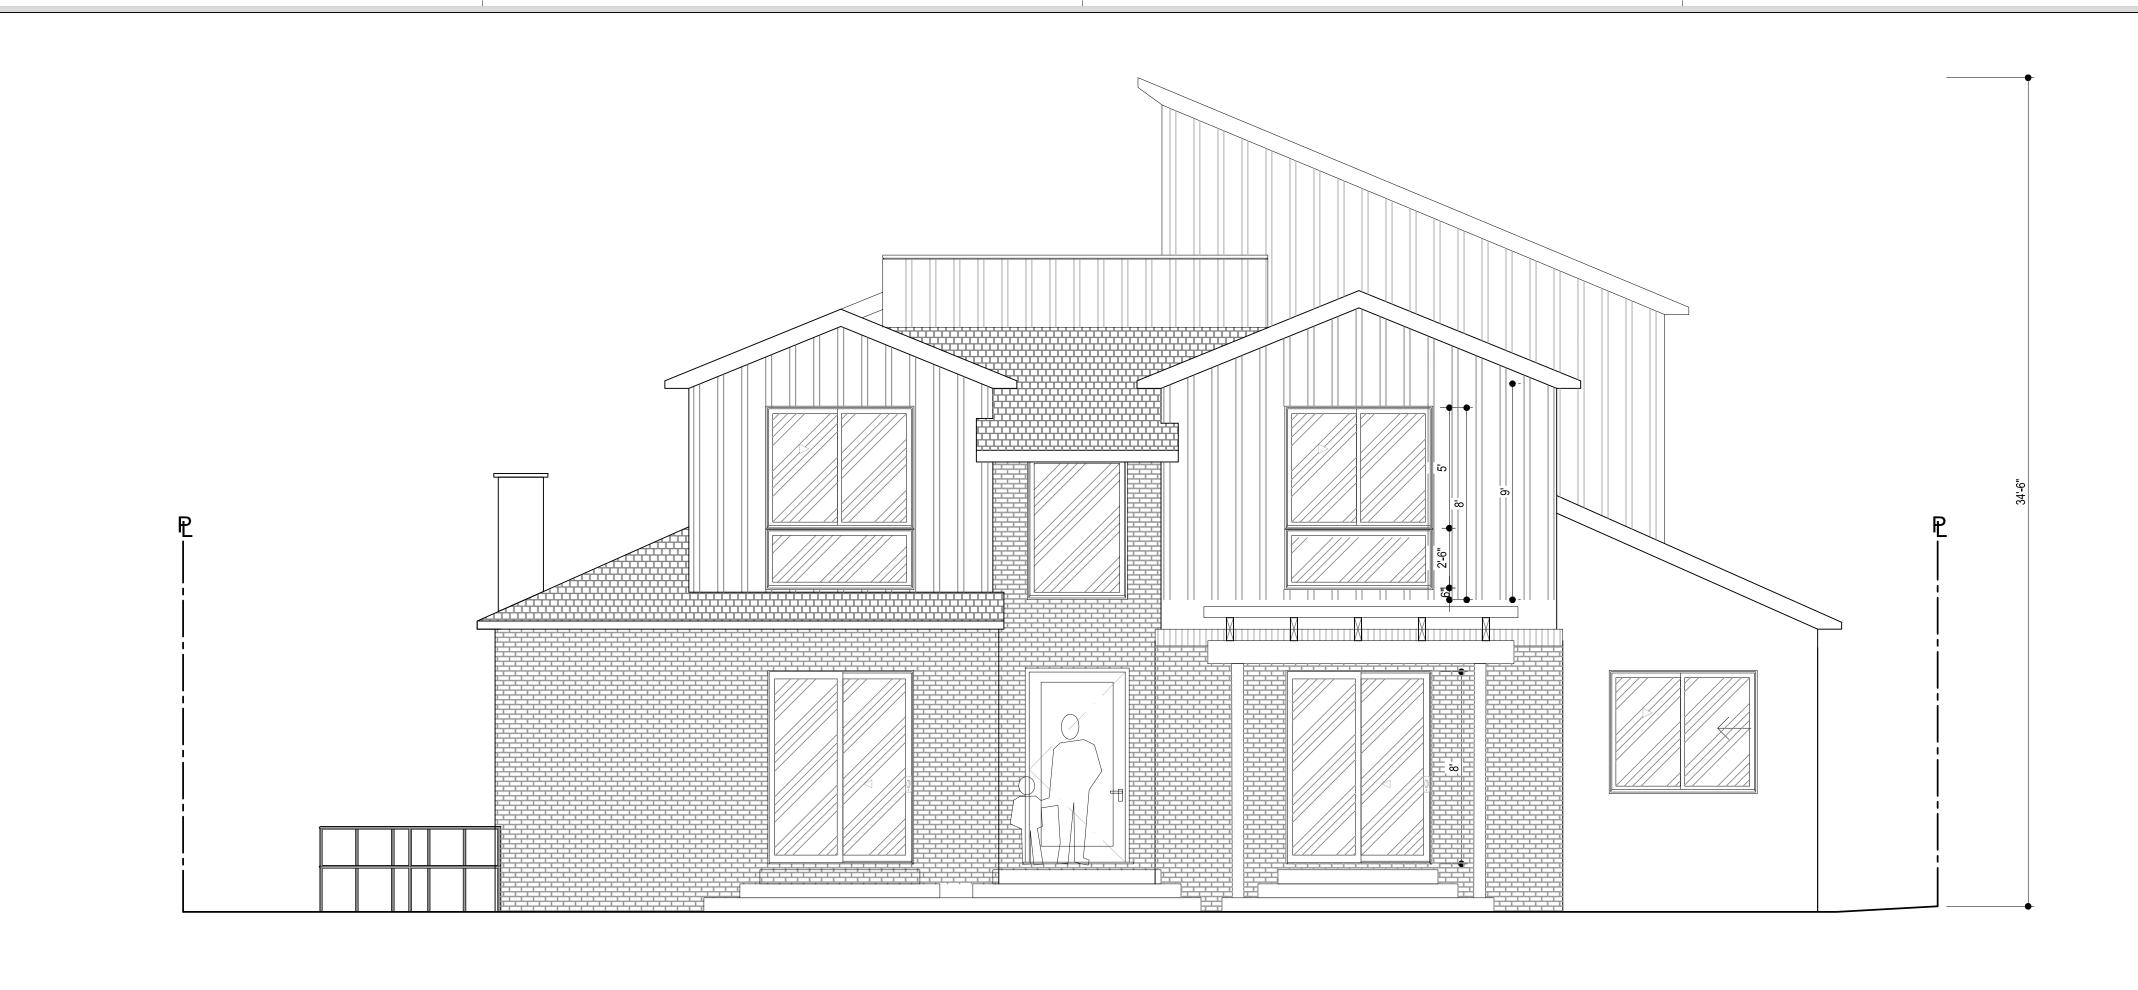
17. EXISTING CONCRETE SLAB AND CONCRETE FOUNDATION TO REMAIN, VERIFY FTNG. DIM. 12"x12" MIN.

18. NEW CONCRETE SLAB AND CONCRETE FOUNDATION [SEE STRUCTURAL PLANS]

19. EXISTING ROOF TO REMAIN UNDER NEW CALIFORNIA ROOFING

20. NEW CEILING JOISTS BY STRUCTURAL PLANS @ 16" O.C.

21. REMOVE EXISTING OPENING AND IN-FILL WALL 22. NEW ATTIC VENTS PER VENTILATION CALC. SEE A-1.2



[NORTH] LINDBROOK DR. FRONT ELEVATION

1/4"=1'-0"



[EAST] SELBY AVE. SIDE ELEVATION

JOB #: **2108-KHAIAT**

REVISIONS

SHEET TITLE:

DRAWING NUMBER

AS NOTED

DATE: APRIL 16, 2021

PRELIMINARY

ELEVATIONS

& DETAILS

DIZITTI

ARCHITECTS Inc.

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T (818) 710 -7482

F (818) 745 -5329

ELEVATIONS / SECTIONS NOTES 1. EXTERIOR STUCCO OVER METAL LATH AND 15 LBS. MIN. FELT PAPER COLOR AND TEXTURE TO BE SELECTED BY OWNER. 2. RAIN TANK PER L.I.D. 3. RAIN GUTTER 4. CLASS 'A' FIRE RETARDANT 20 YR. MIN. COMPOSITION SHINGLES. SEE SPECS ON ROOF PLAN. 5. EXTERIOR EXPOSED OPEN HARDWOOD DECKING. MATERIAL APPROVED PER L.A. BLDG. CODE 6. WATER CRICKET 7. EXISTING ROOF LINE TO BE REMOVED 8. R-38 COMPRESSED FIBER MINERAL BATT. INSULATION 9. R-13 FIBER MINERAL BATT. INSULATION AT ALL EXTERIOR WALLS 10. NEW DOORS PER SCHEDULE. [SEE A-2] 11. NEW WINDOWS PER SCHEDULE. [SEE A-2] DIZITTI 12. EXISTING ROOF RAFTER 13. 2x4 DOUBLE PLATE 14. 2x4 P.T. SILL PLATE 15. NEW RIDGE BOARD ARCHITECTS Inc. 16. EXISTING HEADER 17. EXISTING CONCRETE SLAB AND CONCRETE FOUNDATION TO REMAIN, VERIFY FTNG. DIM. 12"x12" MIN. 21243 Ventura Blvd. # 115 18. NEW CONCRETE SLAB AND CONCRETE FOUNDATION [SEE STRUCTURAL PLANS] Woodland Hills, CA 91364 19. EXISTING ROOF TO REMAIN UNDER NEW CALIFORNIA ROOFING T (818) 710 -7482 20. NEW CEILING JOISTS BY STRUCTURAL PLANS @ 16" O.C. F (818) 745 -5329 21. REMOVE EXISTING OPENING AND IN-FILL WALL fdzt@dizittiarchitects.com 22. NEW ATTIC VENTS PER VENTILATION CALC. SEE A-1.2 www.dizittiarchitects.com

NEW 2-STORY O/ BASEMENT S.F.D.
for: LAURENT & AKEMI KHAIAT

1/4"=1'-0" (

[SOUTH] REAR ELEVATION

PRELIMINARY

SHEET TITLE:

DATE: APRIL 16, 2021

REVISIONS

ELEVATIONS
& DETAILS

DRAWING NUMBER

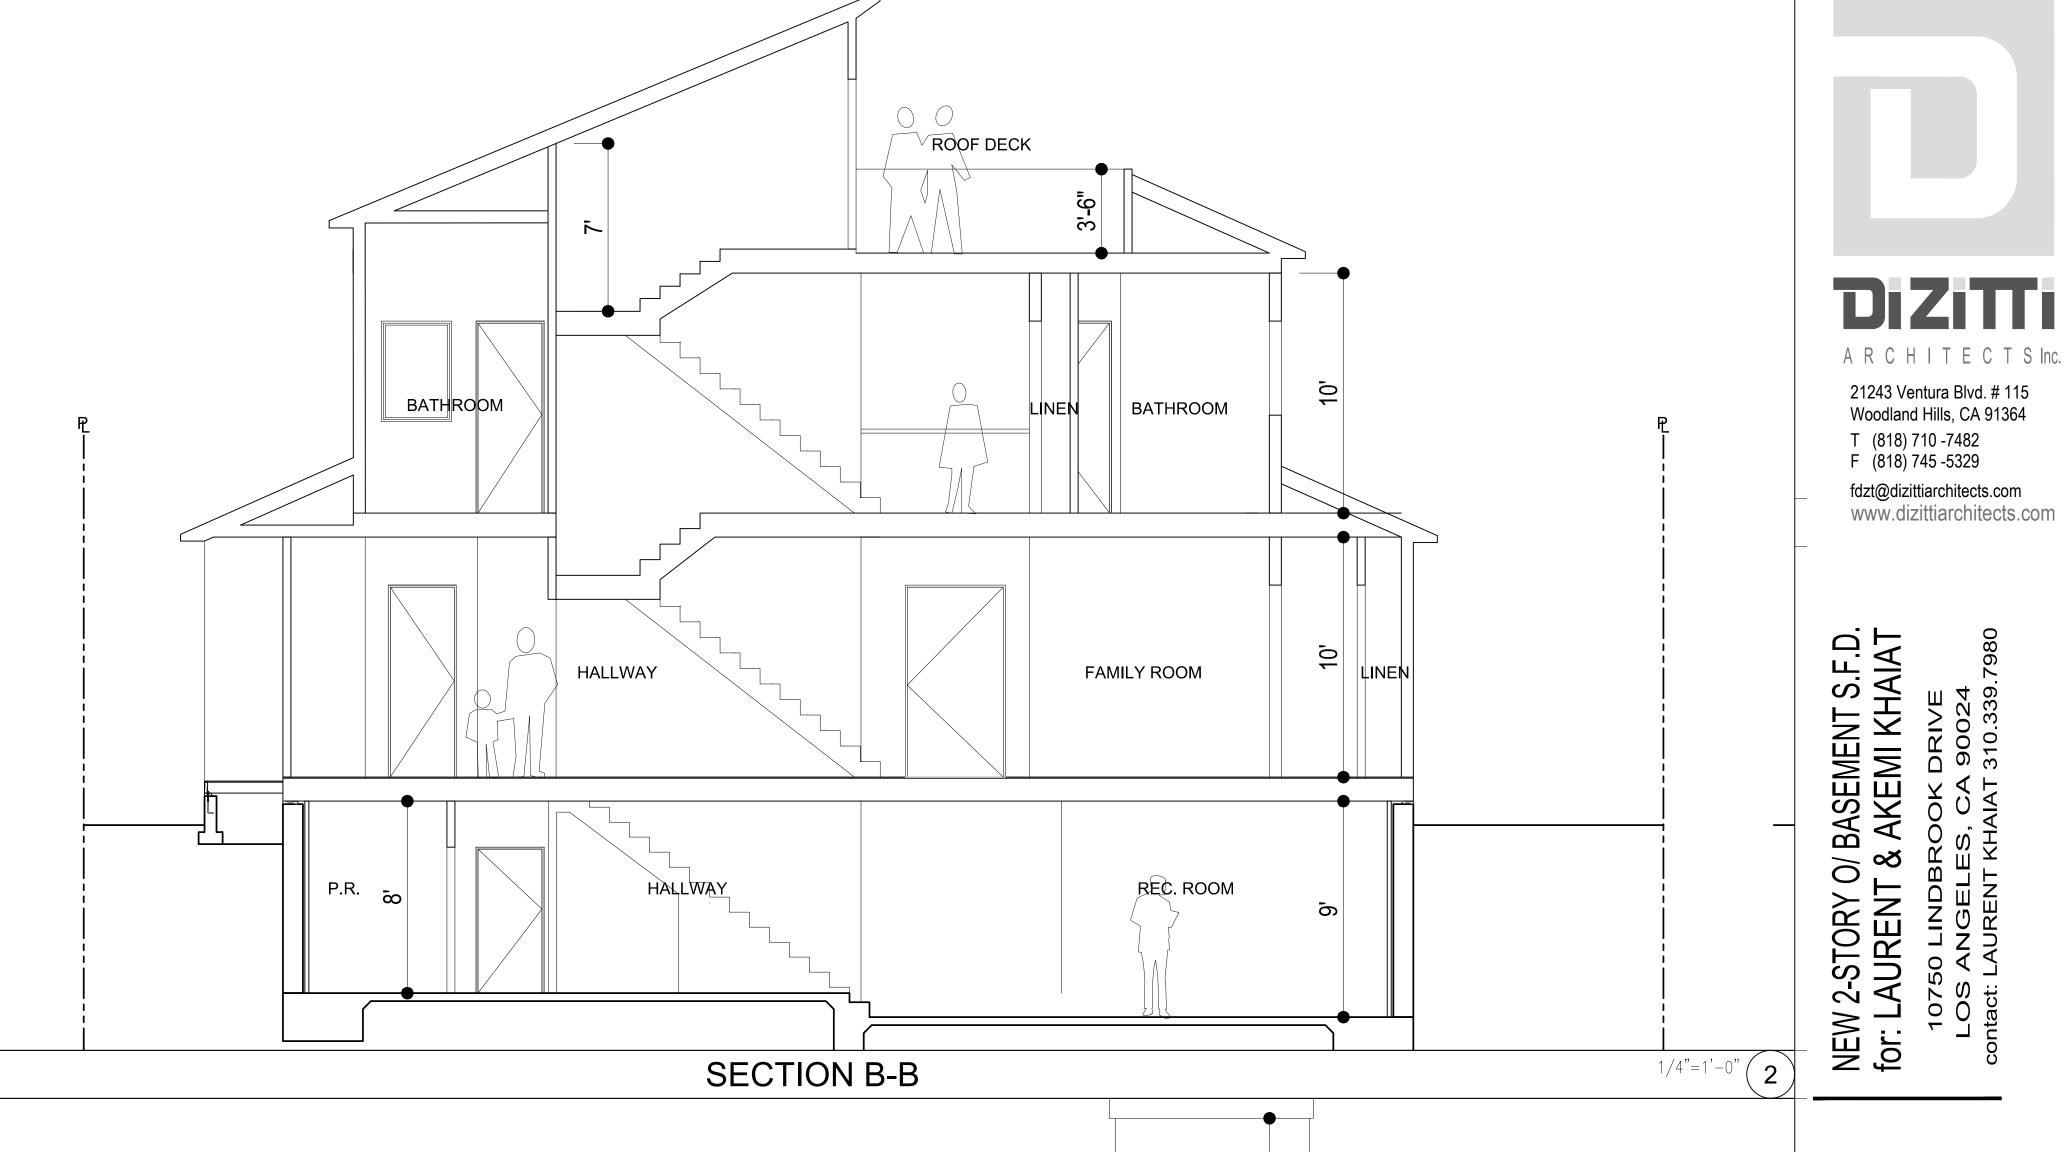
A-3.2

1/4"=1'-0"

[WEST] SIDE ELEVATION

JOB #: **2108-KH**

ELEVATIONS / SECTIONS NOTES # 1. EXTERIOR STUCCO OVER METAL LATH AND 15 LBS. MIN. FELT PAPER COLOR AND TEXTURE TO BE SELECTED BY OWNER. 2. RAIN TANK PER L.I.D. 3. RAIN GUTTER 4. CLASS 'A' FIRE RETARDANT 20 YR. MIN. COMPOSITION SHINGLES. SEE SPECS ON ROOF PLAN. 5. EXTERIOR EXPOSED OPEN HARDWOOD DECKING. MATERIAL APPROVED PER L.A. BLDG. CODE 6. WATER CRICKET 7. EXISTING ROOF LINE TO BE REMOVED 8. R-38 COMPRESSED FIBER MINERAL BATT. INSULATION 9. R-13 FIBER MINERAL BATT. INSULATION AT ALL EXTERIOR WALLS 10. NEW DOORS PER SCHEDULE. [SEE A-2] 11. NEW WINDOWS PER SCHEDULE. [SEE A-2] 12. EXISTING ROOF RAFTER 13. 2x4 DOUBLE PLATE 14. 2x4 P.T. SILL PLATE 15. NEW RIDGE BOARD 16. EXISTING HEADER 17. EXISTING CONCRETE SLAB AND CONCRETE FOUNDATION TO REMAIN, VERIFY FTNG. DIM. 12"x12" MIN. 18. NEW CONCRETE SLAB AND CONCRETE FOUNDATION [SEE STRUCTURAL PLANS] 19. EXISTING ROOF TO REMAIN UNDER NEW CALIFORNIA ROOFING 20. NEW CEILING JOISTS BY STRUCTURAL PLANS @ 16" O.C. 21. REMOVE EXISTING OPENING AND IN-FILL WALL 22. NEW ATTIC VENTS PER VENTILATION CALC. SEE A-1.2



ROOF DECK

MASTER BEDROOM

FAMILY ROOM

SECTION A-A

BALCONY

SAUNA

Woodland Hills, CA 91364

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www.dizittiarchitects.com

REVISIONS cad file: 2108-KHAIAT-MSTR1

FOYER

REC. ROOM 5

AS NOTED

DATE: APRIL 16, 2021

PRELIMINARY

SHEET TITLE:

SECTIONS & DETAILS DRAWING NUMBER

1/4"=1'-0" (**1** JOB #: **2108-KHAIAT**

REAR

TRELLIS